


N First Floor Plan - Existing + Demolition


FIRST FLOOR: 17,825 GSF SECOND FLOOR: 20,920 GSF TOTAL: 28,746 GSF

CJHAS CR,CR

3104 0 M195 D1.1 EXISTING + DEMO FIRST FLOOR PLAN

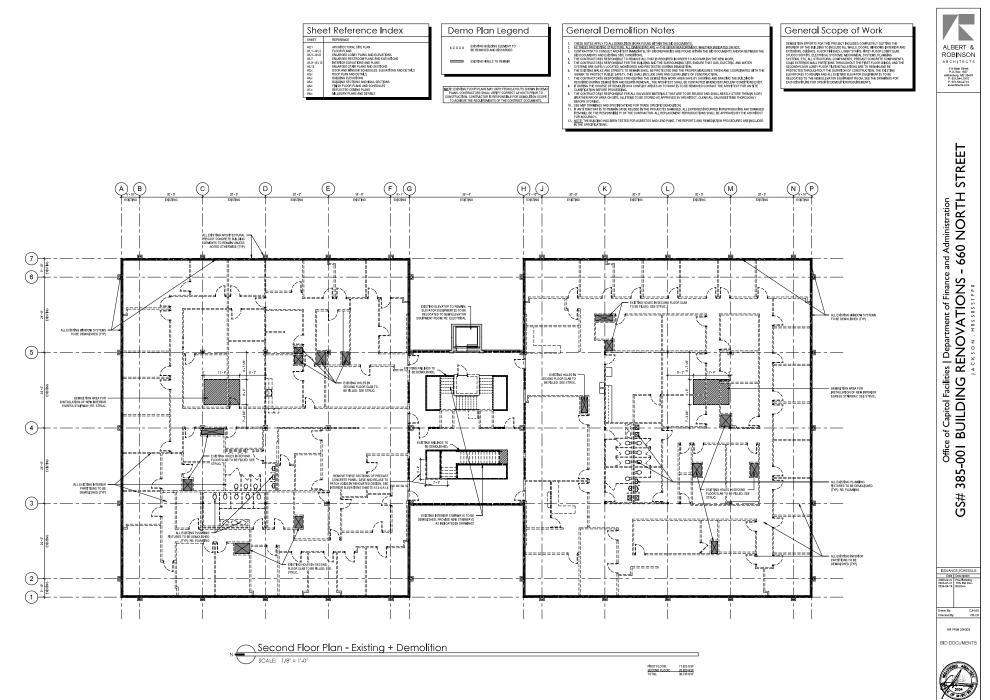

D1.2 EXISTING + DEMO SECOND FLOOR PLAN

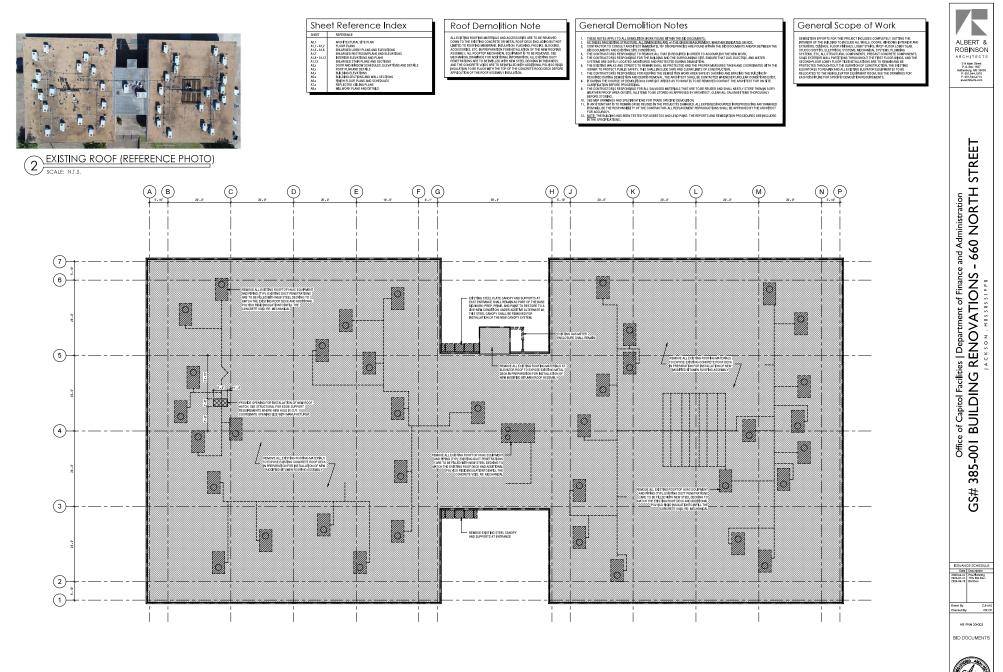


N Roof Plan - Existing + Demolition

LE: 1/8" = 1'-0"

D3.1 EXISTING + DEMO ROOF PLAN

3104 07 M195

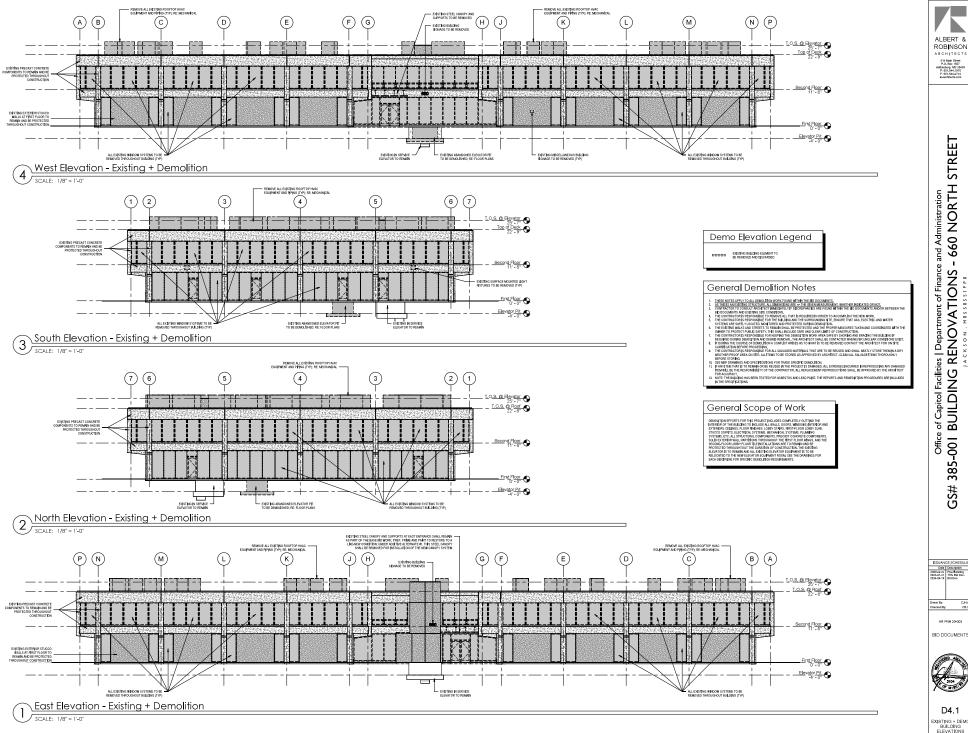



Office of Capitol Facilities | Department of Finance and Administration GS# 385-001 BUILDING RENOVATIONS - 660 NORTH STREET

Date Description 2020.cr.oc Pre-Plenning 2023.01.31 75% Bild Dec. Drawn By: Checked By: CJHA CR/C AR PN# 20-003 BID DOCUMENTS

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D4.1



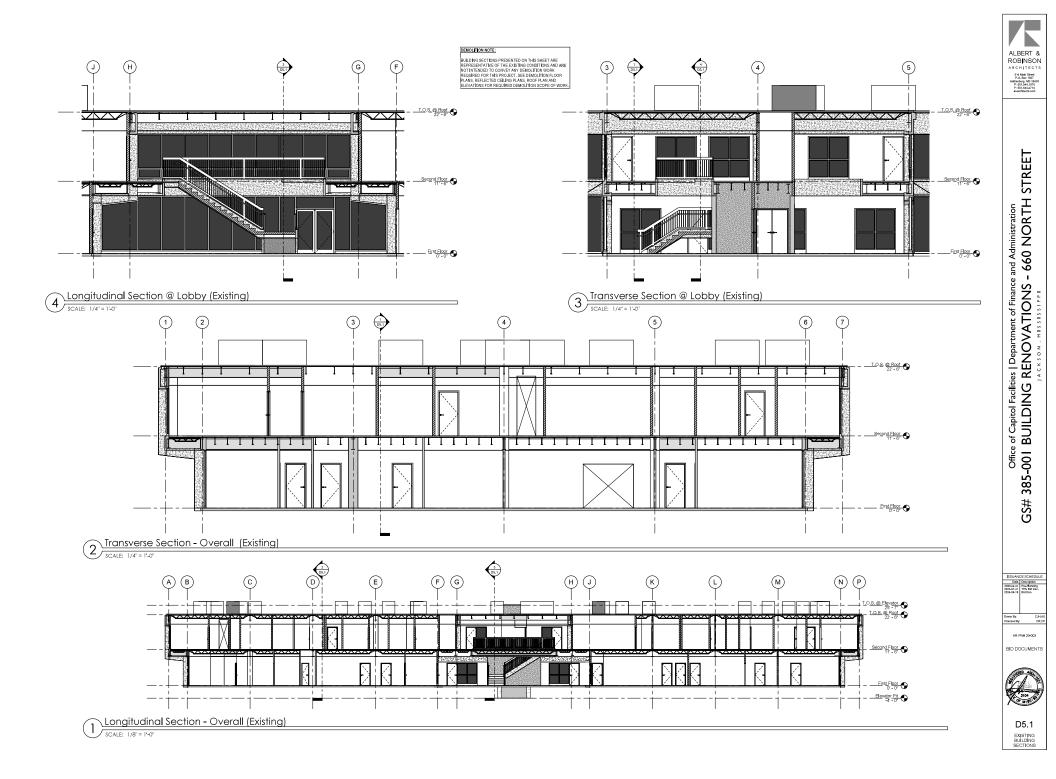


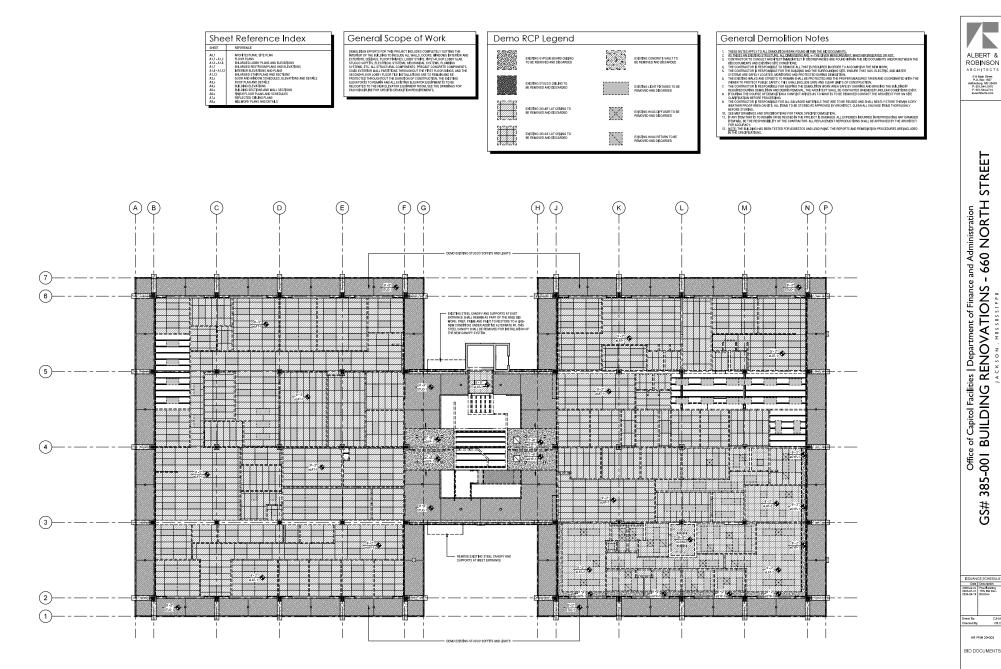EXISTING + DEMO

First Floor RCP - Existing + Demolition
 SCALE: 1/8"=1-0"

D7.1

CJHA CR/C

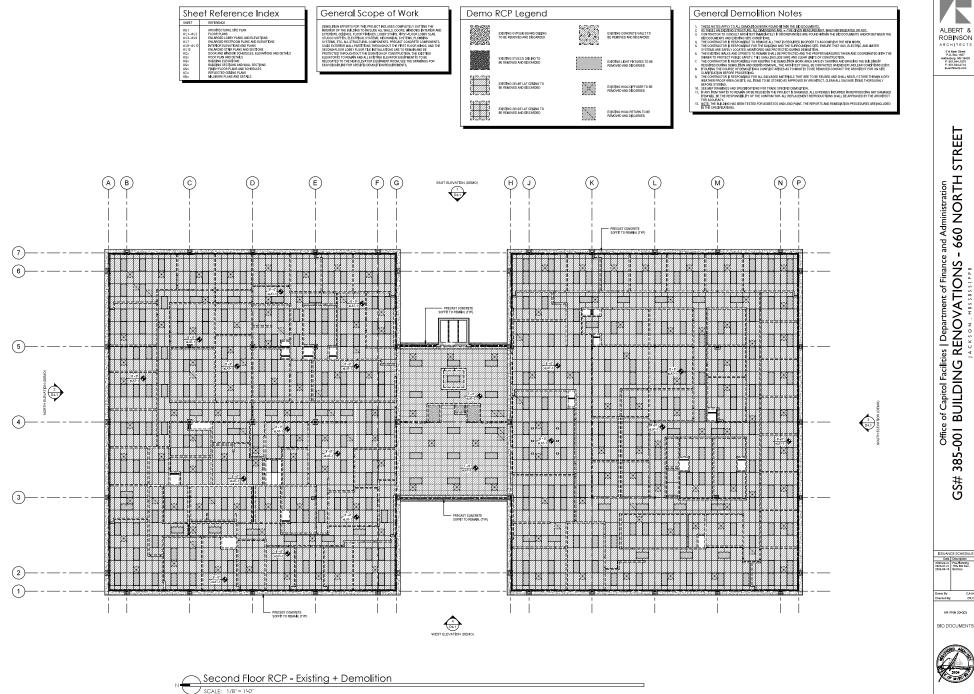

D7.2 EXISTING + DEMO SECOND FLOOR RCP

PLANTING (LANDSCAPING) NOTES

PLANTING ILANDSCAPENG) CONSTRUCTION DOCUMENTS — THESE REARTING ILANDSCAPENG CONSTRUCTION DOCUMENTS ARE PROVIDED FOR BIDONIG PUBROSES ONLY, THAL SECTION AND LYOUTO FLANTINGS SHALL BE PROVIDED BY THE CONTRACTOR AND SUBMITED T THE OWNER AND ARCHITECT FOR REVIEW AND APPROVAL BEFORE MAY MATERIALS ARE PURCHASED.

THE CONTRACTOR SHALL SUBMIT PLANTING SHOP DRAWING WATCHING THE LANDSCAPE DRAWING SCALES DED IN THESE DRAWINGS. THE PLANTING SHOP DRAWINGS SHALL INDICATED THE FINAL SELECTION OF UNGS AND LAYOUT ON PLANTINGS AS DETERMINED WITH THE OWNER AFTER AVARIOD OF THE CONSTRUCTION

PROVIDE AND INSTAUL TREES, SHRUBS, GROUNDCOVER, SEED, SPRIGS, AND SOD AS SHOWN. ALL PLANT MATERIAL SHALL MEET OR BCCEED SIZE STANDARDS SET FORTH IN "AMERICAN STANDARD FOR NUSSERN STOCK". SOL: 13966. MATERIAL SHALL CONTOM TO STATE AND FOEDERAL REQUIREMENTS TO RIN INSECT AND DISEASE CON TRADA STANDARD STANDARD SET FORTH IN "AMERICAN DISEASE AND STANDARD FOR NUSSERN STOCK".

2. 4" MINIMUM DIPTH OF TOPSOL OR DEPTHS OTHERWISE INDICATED SHALL BE PROVIDED OVER ALL LANDSCAPED AREAS INCLUIDING ALL GRASS SOD SPRIG AREAS, TREES, HINURS, BLOS, AND GROUND COVER AREAS. PLACE AND SPRIAD TOPSOL WHICH IS FREL OF WIELDS, SEEDS, SEASES, DEBRS, AND OTHER SUBSTANCES HARMF TO FLAVIT GROWTH, LESS THAN 39% SILT. TOP SOL IS PROVIDED IN THE STEWORY INCLAME.

PREPARE ALL TOPSOL MIX USED IN TREE AND SHRUB PITS AND IN GROUNDCOVER BEDS IN THE FOLIC 3. PROPORTIONS: 4-PARTS TOPSOIL AS SPECIFIED - DESCRIPTION DESCRIPTION: - D

2-PARTS DECOMPOSED ORGANIC MATTER 2-PARTS SAUD PREMIX SOIL BEFORE PLACING IN BED OR PIT. PLACE AND SPREAD MINIMUM 6° DEPTH OF TOPSOIL N BEDS.

FINE GRADE TO PROVIDE ADEQUATE SURFACE DRAINAGE AWAY FROM BUILDING(S) AND TO PREVENT

STARE PLANT LOCATIONS FOR APPROVAL BY THE OWNER AND LANDSCAPE ARCHITE IDJUST STARED LOCATIONS AS DIRECTED.

6. CONTRACTOR IS RESPONSIBLE FOR PROVIDING ADEQUATE TREE PIT DRAINAGE. INADEQUATE DRAIN DEFINED BY THE FOLLOWING: FLODO EMPTY TREE PIT TO LEVEL OF SURROUNDING SOIL; IF WATER FAILS TO PERCOLATE OUT WITHIN 24-HOUR PERIOD, DRAINAGE IS INADEQUATE.

- 7. REMOVE FROM SITE ANY PLANT MATERIAL WHICH TURNS BROWN OR DEFOLIATES WITH FIVE (5) DAYS AFTI PLANTING, RIPLACE IMMEDIATELY WITH APPROVED SPECIFIED MATERIAL.

MAINTAIN ALL PLANT MATERIAL AND LAWN AREAS UNTIL SUBSTANTIAL COMPLETION, UN SPECIFIED. (MAINTENANCE INCLUDES WATERING, SPRAYING, WEEDING, MULCHING, STRAIGHTEN FERTILIZING, ETC. AS SPECIFIED).

9 GLIABANTEE ALL MATERIAL AND WORKMANSHIP FOR A PERIOD OF ONE (1) YEAR 10. NO GRAFTED MAPLES WILL BE ACCEPTED.

11. MAIN LEADERS OF ALL TREES SHALL REMAIN INTACT.

12. ALL ORMAMENTAL AND LARGE SHADE THELIS MUST BE OBTAINED FROM NURSIRIES ON THE "APPROVED THEE NURSIRY UST," THE CONTINUES TO BE RESPONSIBLE FOR PROVIDING QUALITY THESE THAT ARE UNFORM WITH THELE VERY BACKAGE AND MEET THE SIZE SPECIFICATIONS. BROKERED THEES AND TREES GROWN BY THE CONTRACTOR ARE NOT PERMISSIBLE.

13. CONTACT THE LANDSCAFF ARCHETCT PROX TO MARCHET THE FUNC-WSL DICISIONS IF THERE IS ANY DOUBLE ADD/T COMMANNACE WITH THE SECRETARIANS, INJURY MARCHAES AS DIFFCTO TO VIEW THE SECRETARIAN DEVICE INJURY WITH THE INJURY MARCHAES AND ANY DIFFCTOR TO VIEW THE SECRETARIAN AND ANY DIFFCTOR TO VIEW AND ANY DIFFCTOR AND ANY DIFFCTOR TO VIEW AND ANY DIFFCTOR AND ANY DIFFCTOR AND ANY DIFFCTOR TO VIEW AND ANY DIFFCTOR AND

14. PRAVING 915 ARE TO BE EXCAVATED AS INDICATED ON THE PRAVING DETAILS IN THISE CONSTRUCTION DOCUMENTS. EXCAVATION WITH AUGURED POLISIS RECOMMONED. ALL HOLES WILL HARV EVERTICAL SOBS AND ALLOW AN UNIAMUM OF SITO YOS UN KEROCILLON THE SIGNED OF ALL TRESS AND PARIDUA LL SHARDES. THE MIX WILL CONSIST OF 1/2 NATIVE SOIL AND 1/2 TOPSOIL BACKFILL. PROVIDE TOPSOIL SAMPLE FOR APPROVAL.

4

PLAN

2

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(3)

THE CONTRACTOR IS TO PROVIDE DRAINAGE FOR ANY PLANTING PITS THAT DO NOT DRAIN BY DRILLING 4* DIAMETER HOLES THROUGH THE HARDAWA AND FILLING WITH GRAVEL. CONTRACTOR IS RESPONSIBLE FOR PROPE DRAINAGE IN ALL BIDS AND SHARE PLANTING PITS.

16. ALL SHRURS ARE TO BE CONSIDERED PLANTED IN A CONTINUOUS SHRUR BID PVEN THOUGH THE SHRURS AN PLANTED IN ROUMDLAL INCLS. THE CONTINECTION IS RESPONDING FOR HARDWARE ALL DISTING GWASS FROM THE BIDWILL BO ANAERA IN BRITS SPANTING THE GRASS WITH HERBICIDE, ALCONING SUFFICIENT TIME FOR THE APPLICATION TO BE EFFECTIVE AND THEN PHYSICALLY REMARKING THE DOAD GWASS.

- TREE STAKING SHALL BE WITH THE ARBOR BRACE SYSTEM AND SHALL BE INCLUDED ON ALL CANDPY TREES NOERSTORY TREES. NO SUBSTITUTIONS.

18. THE CONTRACTOR IS RESPONSIBLE FOR VENIPYING THE LOCATION OF ALL UTILITIES IN THE PROJECT AREA. THE CONTRACTOR IS RESPONSIBLE FOR REPAIRING ANY AND ALL DAMAGES TO EXISTING UTILITIES AS A RESULT OF WORK IN THIS PROJECT.

CONTRACTOR SHALL FINE GRADE AREAS TO BE SPRIGGED. INSTALL SPRIGS AT THE RATE OF 1.000 BUSHELS

20. ALL PLANT MATERIAL SHALL CONFORM TO THE AMERICAN STANDARD FOR NURSERY STOCK, LATEST ADDITION, PUBLISHED BY THE AMERICAN JOINT COMMITTEE ON HORTICULTURAL NOMENCLATURE.

THE CONTRACTOR IS RESPONSIBLE FOR APPLYING FOR AND OBTAINING ALL NECESSARY PERMITS FROM ALL NMENT AUTHORITIES HAVING AUTHORITY OVER THIS PROJECT.

22. CONTRACTOR SHALL BE RESPONSIBLE TO A VERITING THE FINAL SLEECTION OF THESE AND SHELBES TO BE RUBINALDARE IN COMPLIANCE WITH ALL CONTRIBUTING THE FINAL SLEECTION OF THESE AND SHELBEST TO BE RUBINALDARE AND RUBINAL STRUCTURES AND RUBINAL STRUCTURES AND RUBINAL STRUCTURES AND RUBINAL RUBINALS THE A PARAMENTATION RESPONSIBLE TWO RUBINAL STRUCTURES AND RUBINAL RUBINALS THE A PARAMENT AND RUBINAL STRUCTURES AND RUBINAL RUBINAL RUBINAL RUBINAL RUBINALS THE A PARAMENT AND RUBINAL RU

GENERAL LANDSCAPING & IRRIGATIONS NOTES

VERIFY ALL UTILITY LOCATIONS IN THE FIELD BEFORE BEGINNING WORK. REPAIR TO DJ PERFORMED AT NO ADDITIONAL COST TO THE OWNER.

ANDSCAPING AND IRRIGATION LAYOUTS AS REQUIRED FOR EXISTING CONDITIONS, STORM WATEI IR PREVIOUSLY INSTALLED SITE WORK ITEMS.

COORDINATE THE LANDSCAPING DESIGN AND INSTALLATION WITH ALL UNDERGROUND AND OVERHEAD SITE UTILITIES.

. COORDINATE THE ADJUSTMENT OF THE TOP OF GRATE INLET ELEVATIONS TIED TO THE STORM DRAINAGE INSTEM WITH THE CIVIL ENGINEER TO PROVIDE POSITIVE DRAINAGE THROUGHOUT THE SITE.

5. PROVIDE LABOR, EQUIPMENT, MATERIALS, AND SERVICES NECESSARY TO COMPLETE WORK.

ALL MATERIALS ARE SUBJECT TO APPROVAL OF THE ARCHITECT AND OWNER AT ANY TIME.

SIDEWALK AND HARDSCAPE SURFACES NOTES


. CONTRACTOR SHALL COORDINATE SLOPES, CROSS SLOPES, AND ALL OTHER COMPONENTS OF ALL HARDSCA URFACES (SIDEWALKS, PATIOS, ETC.) TO COMPLY WITH 'ADA' ACCESSIBILITY STANDARDS SUCH AS SIDEWALKS IN CORRENT ED RUTH WITHOUT THE LIST OF RANGE.


ADDITIONAL LANDSCAPING AND IRRIGATION NOTES

CONTRACTOR SHALL PATCH ANY EXISTING GRASSED AREAS TO NOTED TO REMAIN THAT GET DAMAGED THE CONSTRUCTION PROCESS. INFIGUTION CONTRACTOR SHALL BE RESPONSIBLE FOR A PUMP AS NEEDED FOR THE IRRIGATION SYSTEM T SPECIFIED. ATION CONTRACTOR SHALL BE RESPONSIBLE FOR OBTAINING ACTUAL SYSTEM PRESSURE AFTER THE VATER ANNA EXTEMPION AND PRINCATION AND TRACER ASSEMBLY HAVE BEEN INSTANLED.



PLANT SCHEDULE										
MARK	COMMON NAME	BOTANICAL NAME	VARIETY	SIZE PLANTED	SPACING	QUANTITY	SIZE MATURITY	ATTRIBUTES	ATTRIBUTES	
CANO	PY TREES									
WOAK	WILLOW CAK	QUERCUS PHELLOS		3.5* CAL MIN 12' HGT. MIN	AS SHOWN	AS SHOWN	40'-75' HEIGHT; 25'-50' SPREAD	DECIDUOUS	FALL-ORANGE/RED	
UNDE	RSTORY TREES						•			
WASH	WASHINGTON HAWTHORN	CRATAEGUS PHAENOPYRUM	FASTIGIATA	2" CAL. MIN 12" HGT MIN.	AS SHOWN	AS SHOWN	25'-30' HEIGHT; 20'-35' SPREAD	DECIDUOUS	SPRING/SUMMER-FLOWER	
MAG	LITTLE GEM MAGNOLIA	MAGNOLIA GRANDIFLORA	LITTLE GEM	8' HGT MIN.	AS SHOWN	AS SHOWN	15'-20' HEIGHT; 7-10' SPREAD	DECIDUOUS	SPRING/SUMMER-FLOWER	
SHRUE	35			•						
UB8	BIG BLUE LIRIOPE	LIRIOPE MUSCARI	SUPER BLUE	B&B - 36" HEIGHT	AS SHOWN	AS SHOWN	18"-20" HEIGHT; 18*-28"SPREAD	PERENNIAL	BLUE FLOWER	
CRH	CARISSA HOLLY	ILEX CORNUTA	CARISSA	7 GALLON	AS SHOWN	AS SHOWN	3'-4' HEIGHT; 3'-4' SPREAD	EVERGREEN	SPRING-FLOWER; FALL PURP	
CIP	CAST IRON PLANT	ASPIDISTRA	ASAHI	8&8 - 12" HDGHT	AS SHOWN	AS SHOWN	1'-3' HEIGHT; 1'-3' SPREAD	PERENNIAL	SUMMER -FLOWER	
RAP	RAPHIOLEPIS (INDIAN HAWTHORN)	RAPHIOLEPIS INDICA	CLARA	7 GSLLON - 20" SPREAD	42° O.C.	AS SHOWN	4'-6' HEIGHT; 4'-6' SPREAD	EVERGREEN	SPRING-FLOWER; FALL PURP	
GRASS	5			•						
	419 BERMUDA SOD									
MISCE	LLANEOUS									
MULCH	NULCH SHREDDED HARDWOOD MULCH - DEPTH 5"			PROVIDE AT ALL GROUND COVER BEDS, LANDSCAPE BEDS, SHRUBS, TREES AND ALL OTHER NOTED LOCATIONS						
EDGING	DGING HEAVY GAUGE STEEL WITH INTERLOCKING METAL STAKE SYSTEM		PROVIDE AT ALL LANDSCAPE BEDS AND ALL OTHER NOTED LOCATIONS. CLARIFICATION: INDIVIDUAL TREE AND SHRUB PLANTINGS SHALL NOT BE PROVIDED WITH EDGING.							

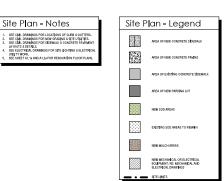

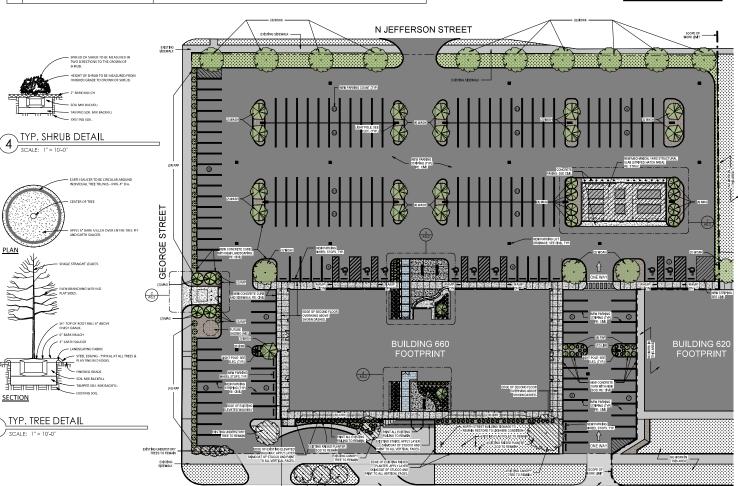

SCALE: 1" = 20'-0"

Architectural Site Plan

ALL EXISTING EXTERIOR RAILING BASES TO BE RE-SEALED WITH EPOXY GROUT AND RE-PAINTED (PT-5)

NORTH STREET

EXISITING PAVING TO REMAIN: SEE CIVIL

EXISTING UN



ALBERT &

ROBINSON

ARCHITECTS

514 Main Street P.O. Box 1567 Hatlesburg MS 3540 P. 601 544 1970 F. 601 544 4714 an architects.com




Date Description 2020 ar.ox Pre-Plenning 2023.01.31 T0% Bid Dec.





191 PARKING SPACES TOTALS:

182 STANDARD SPACES + 9 ADA SPACES

> A0.1 RCHITECTURA SITE PLAN

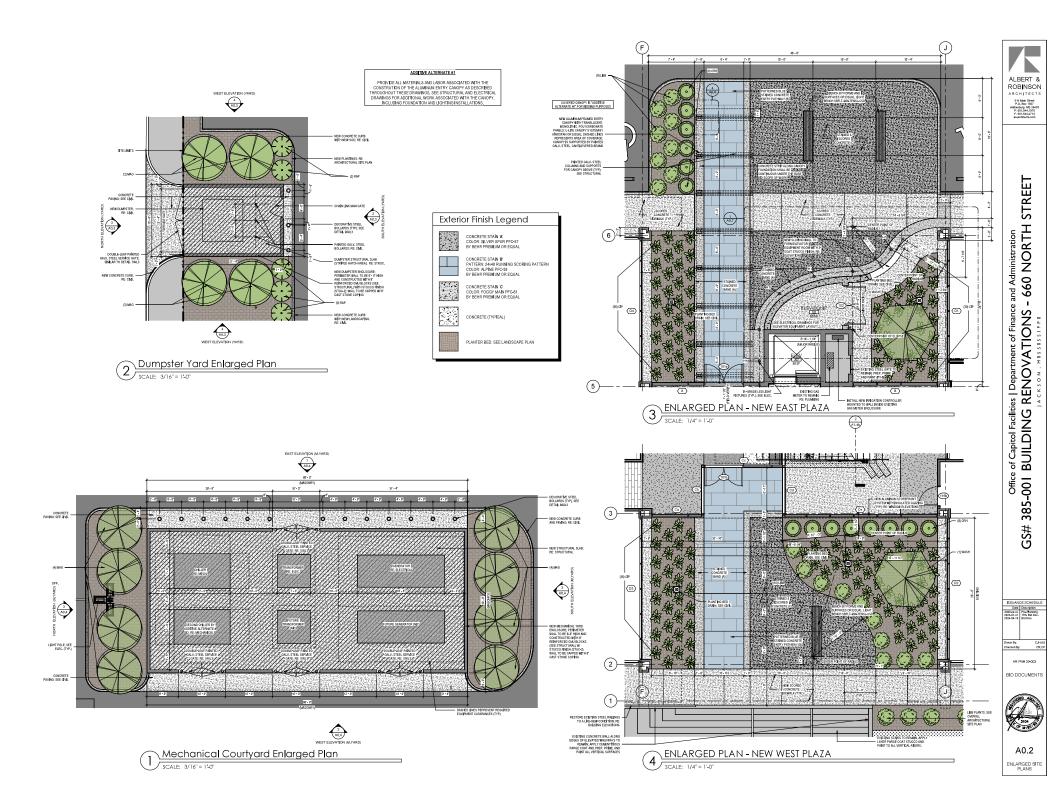

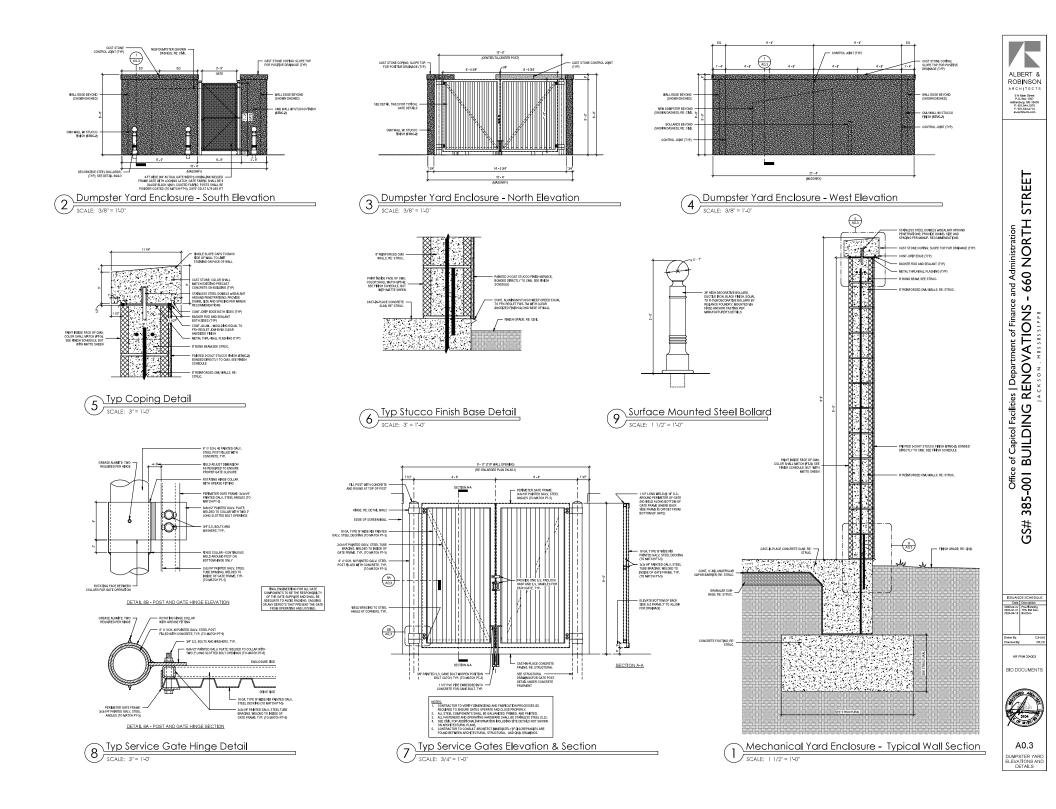

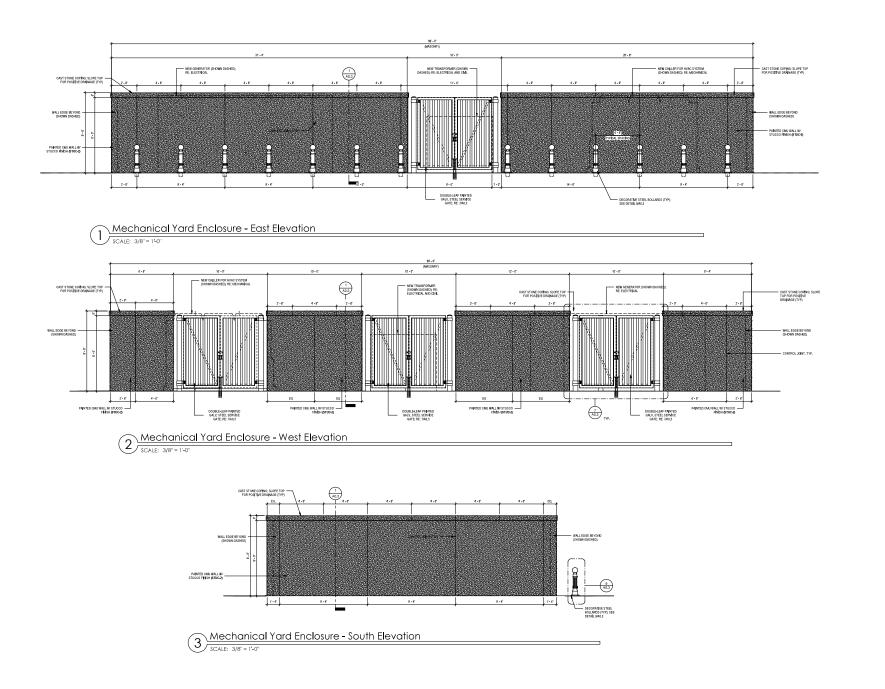

ALBERT & ROBINSON ARCHITECTS 314 Main Streat P.O.00X 1097 Hiddestry 145 34403 P. 6012444/1714 at-antification



ISSUANCE SCHEDULI Date Description 2023.07.02 Pre-Plenning 2023.01.11 75% Bid Dec.

Drawn By: CJHA Checked By: CR,C

AR PN# 20-003

BID DOCUMENTS

3104 0 M195



EXTERIOR 3D RENDERING - NEW WEST ENTRANCE PLAZA




2 EXTERIOR 3D RENDERING - NEW EAST ENTRANCE PLAZA

ALBERT & ROBINSON ARCHITECTS 314 Main Street P.D.Box 1667 Helifecturg MS 3000 P.B.B.M.2714 searchilecturg



ISSUANCE SCHEDULE Date Description 2022.ar.oc Pre-Herning 2023.01.1 T0% Bid Dec. 2024.04.19 Bid Dec.



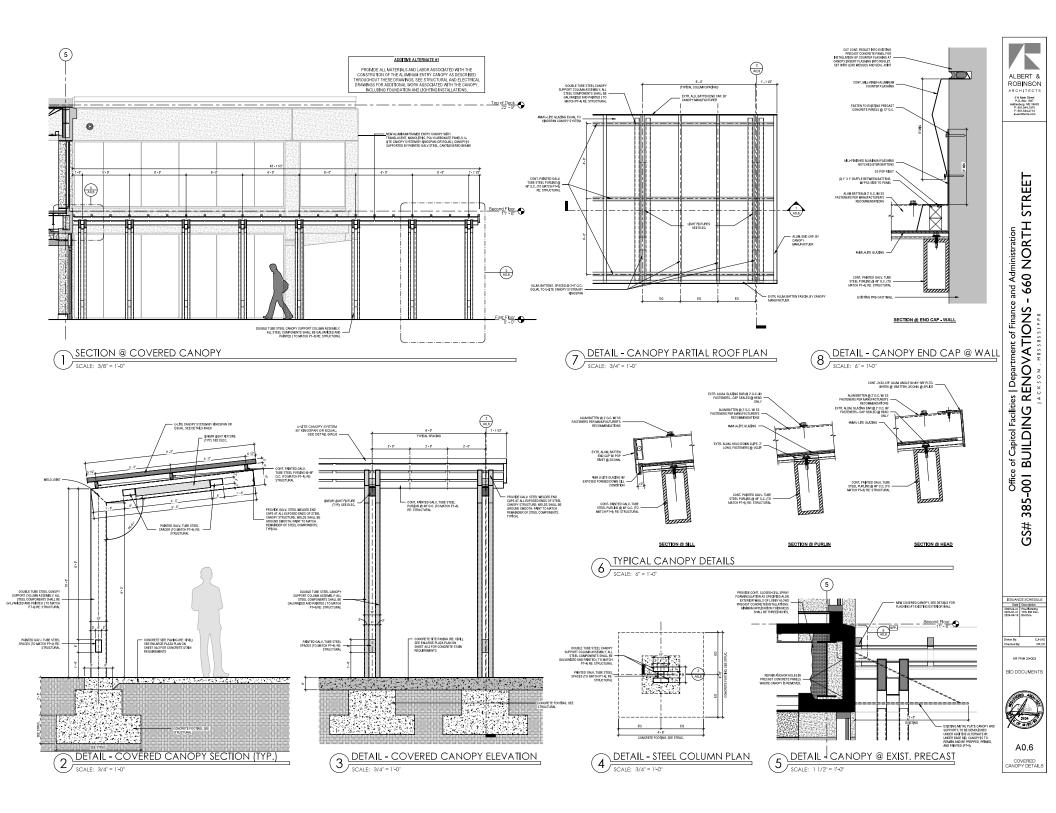

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2 A0.7

> EXISTING ELEVATOR SHAFT WITH STUCCO FINSH TO REMAIN; PREP, PRIME, AND PAINT (PT-7)

> > 0

SLOPE TOP OF WALL TOWARD BACKSIDE OF WALL TO LIMIT STAINING ON FACE OF WALL; MINIMUM SLOPE ACROSS TOP OF WALL SHALL BE 1/2"

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. 7 - 1 1/47

3

SCALE: 3/8" = 1-0

DIGE OF CONCRETE FOUNDATION BELOW, SHOWN DASHED; RE: STRUCTURAL

PROVIDE CONT, CEMENTITIOUS PARAG COAT OVER ENTIRE SURFACE OF CAST IN PLACE CONCRETE WALL AND ELEVATO EQUIPMENT ROOM PAINT TO MATCH PT

CURVING CAST-IN-PLACE CONCRETI WALL: RE: STRUCTURA

1

SCALE: 3/8" = 1-0

CURVING CAST-N-PLACE CONCRETE WALL; RE: STRUCTURAL

EXTERIOR ELEVATION - NEW ELEVATOR EQUIPMENT WALL

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<u>وي المجرمة</u>

ENLARGED PLAN - NEW ELEVATOR EQUIPMENT WALL

anne:

3.0

660

1/2" N C

> PROMDE CONT. CEMENTITIOUS PARAGE COAT OVER ENTRE SURFACE OF CAST-PLACE CONCRETE WALL AND ELEVATOT EQUIPMENT ROOM PAINT TO MATCH PT

> > (\mathbf{J})

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(4) (A0.7)

¢1)

PREFINISHED ALUMINUM DOWNSPOLIT; RE: ROOF PLAN CENTERPOINT OF BLUPSE

- EXISTING GAS METER ENCLOSURE EXISTING GAS METER TO REMAIN; RE: PLUMBING

- EXISTING STEEL GATE TO REMAIN PREP PRIME AND PAINT (PT-S)

INSTALL NEW IRRIGATION CONTROLLER MOUN TO WALL INSIDE EXISTING GAS METER ENCLOSE


FULL ELUPTICAL FOR REFERENCE 26 HUGH PREFINISHED ALUMINUM DIMENSIONAL LETTERS, FINISH SHALL BE BLUE TO MATCH PT-2; SEE SPECIFICATION:

> Office of Capicol Facilities | Department of Finance and Administration GS# 385-001 BUILDING RENOVATIONS - 660 NORTH STREET






A0.7 ENLARGED SITE PLAN & ELEVATIONS

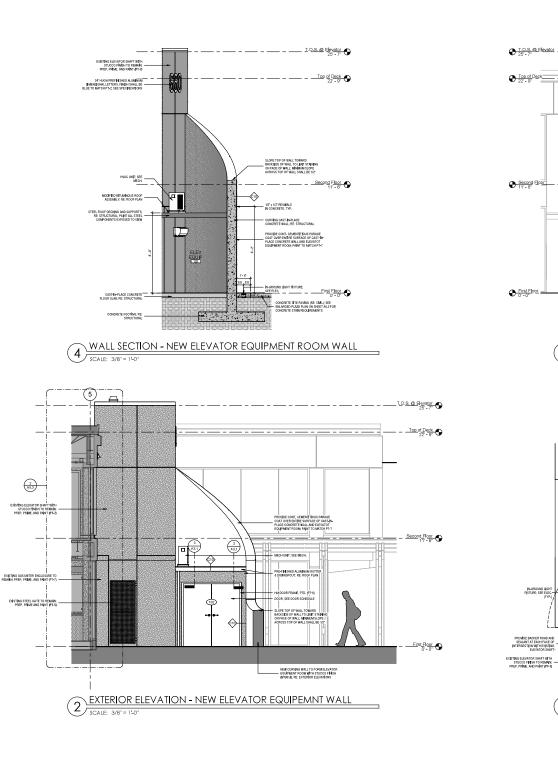


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Office of Capitol Fac SS# 385-001 BUILDIN	

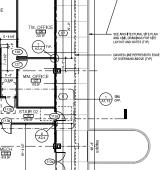

Floor Plan Legend							
(105	DOOR REFERENCE MARK: RE: DOOR SCHEDULE SHE	ET A2,1	WINDOW MARK; RE: WINDOW SCHEDULE SHEET A2.2	(A1)			
	NEW WALLS		DOOR SWING	Λ			
	EXISTING WALLS	P	TERIOR PARTITION TYPE TAG; SEE PARTITION SCHEDULE ON NOTED PLAN SHEET				



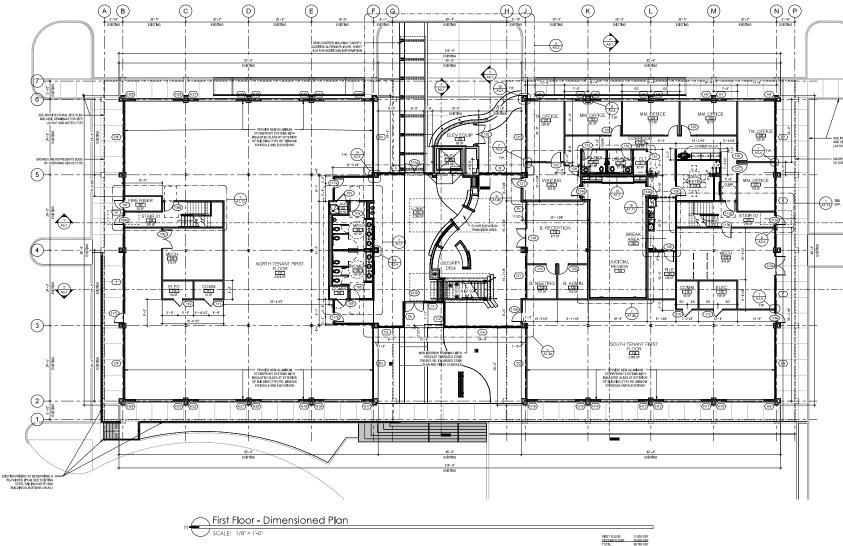

A1.1a FIRST FLOOR -DIMENSIONED PLAN


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Drawn By: Checked By: CJHA CR/C

AR PN# 20-003


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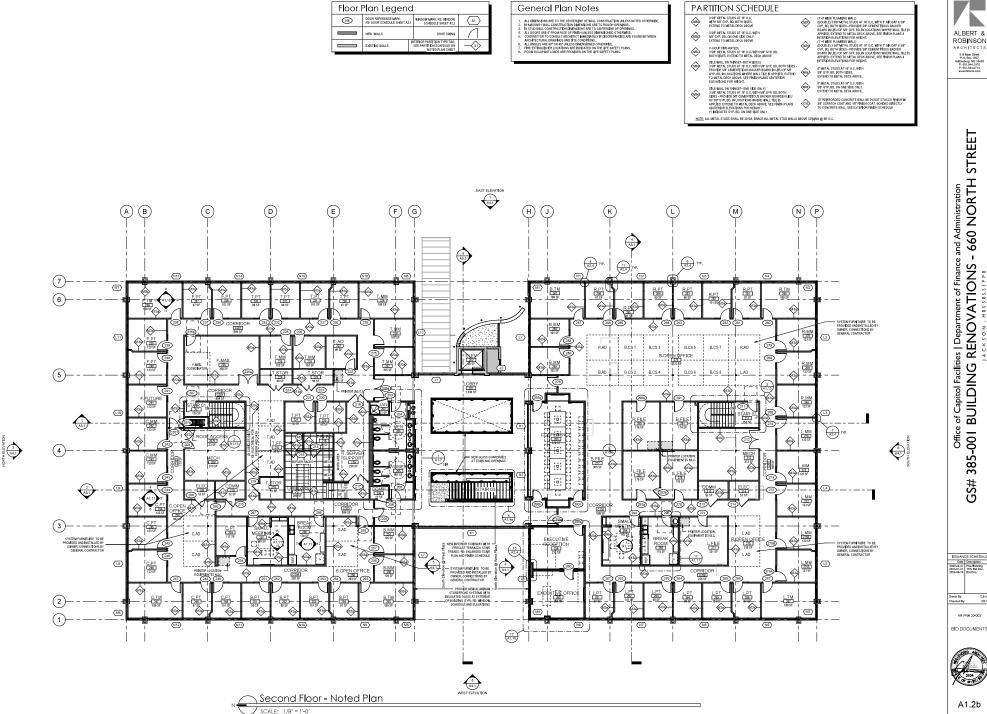
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SCALE: 1/8" = 1'-0"

A1.1b



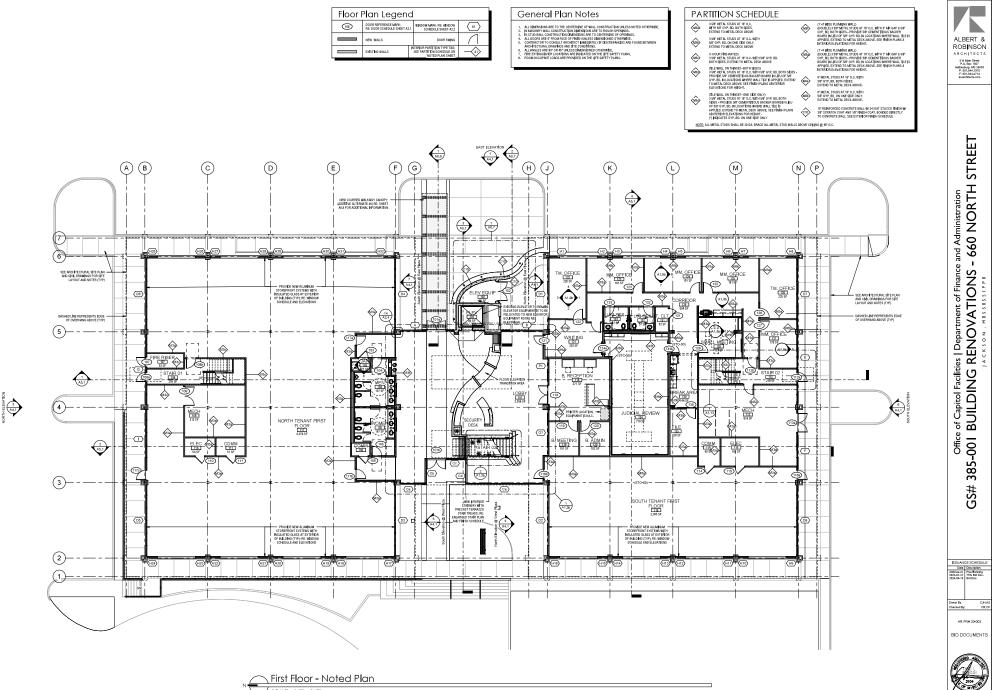

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ARCHITECTS

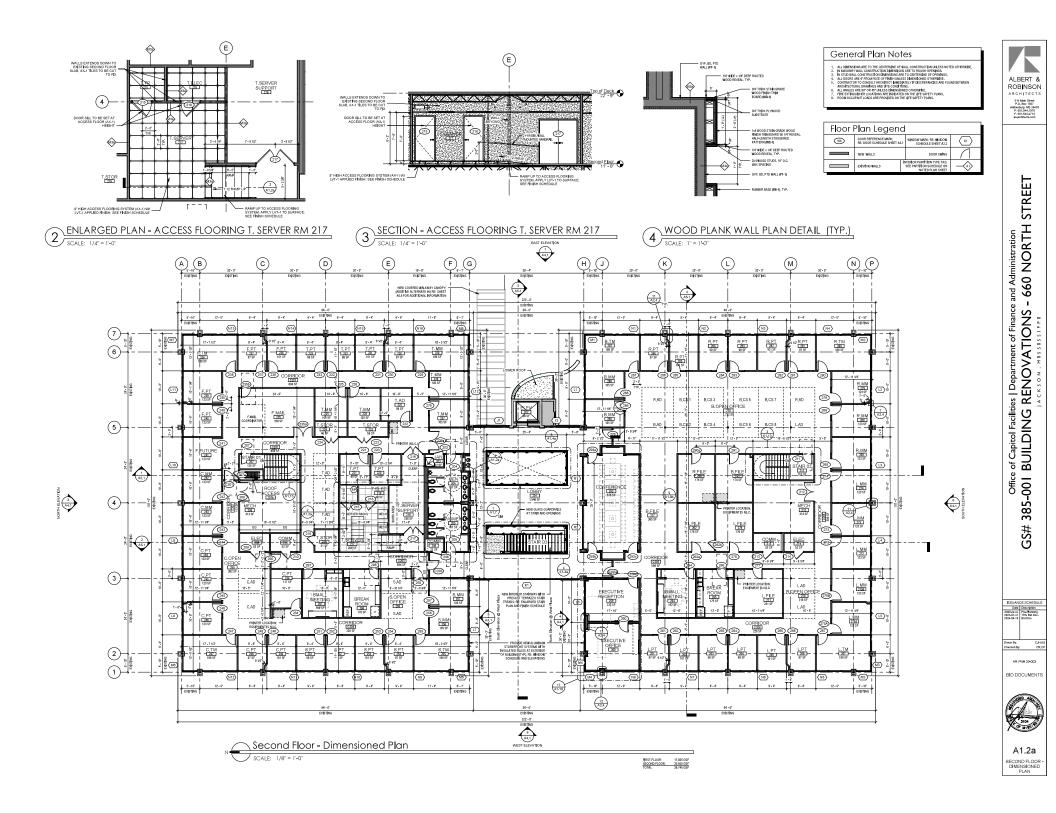514 Main Street P.O. Box 1667 Hattlesburg MS 39403 P: 601.544, 1970 F: 601.544, 4714 an architects.com

BID DOCUMENTS OF M15

AR PN# 20-003

A1.2b

SECOND FLOOR NOTED PLAN

CJHA CR/C




Office of Capitol Facilities | Department of Finance and Administration GS# 385-001 BUILDING RENOVATIONS - 660 NORTH STREET



4 INTERIOR 3D RENDERING - LOBBY 201 VIEW 01 SCALE: N.J.S.

3 INTERIOR 3D RENDERING - LOBBY 101 VIEW 03 SCALE: N.I.S.

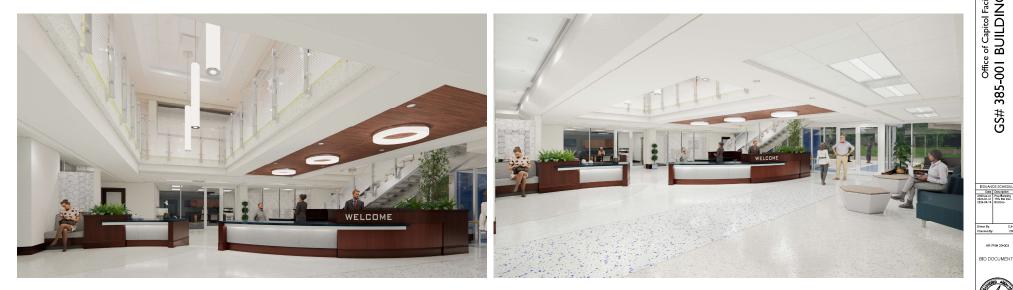


2 INTERIOR 3D RENDERING - LOBBY 101 VIEW 02 SCALE: N.I.S.








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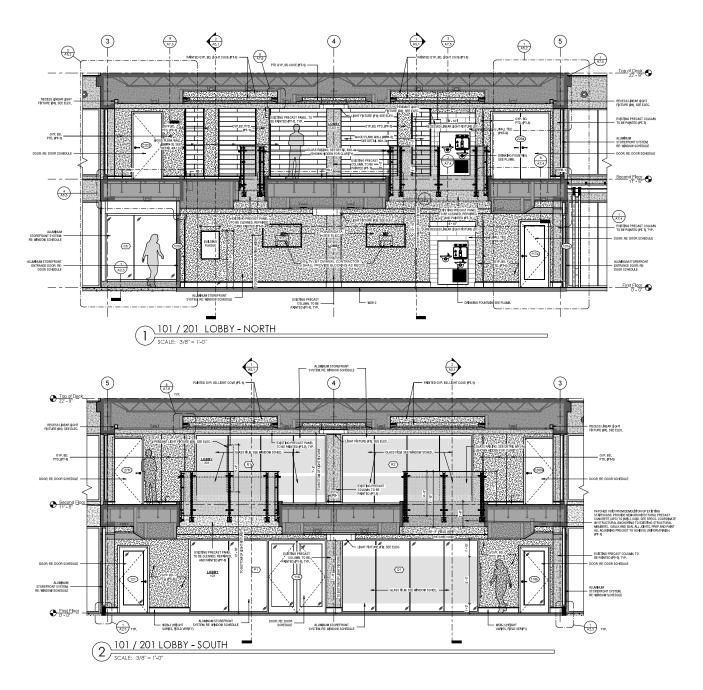


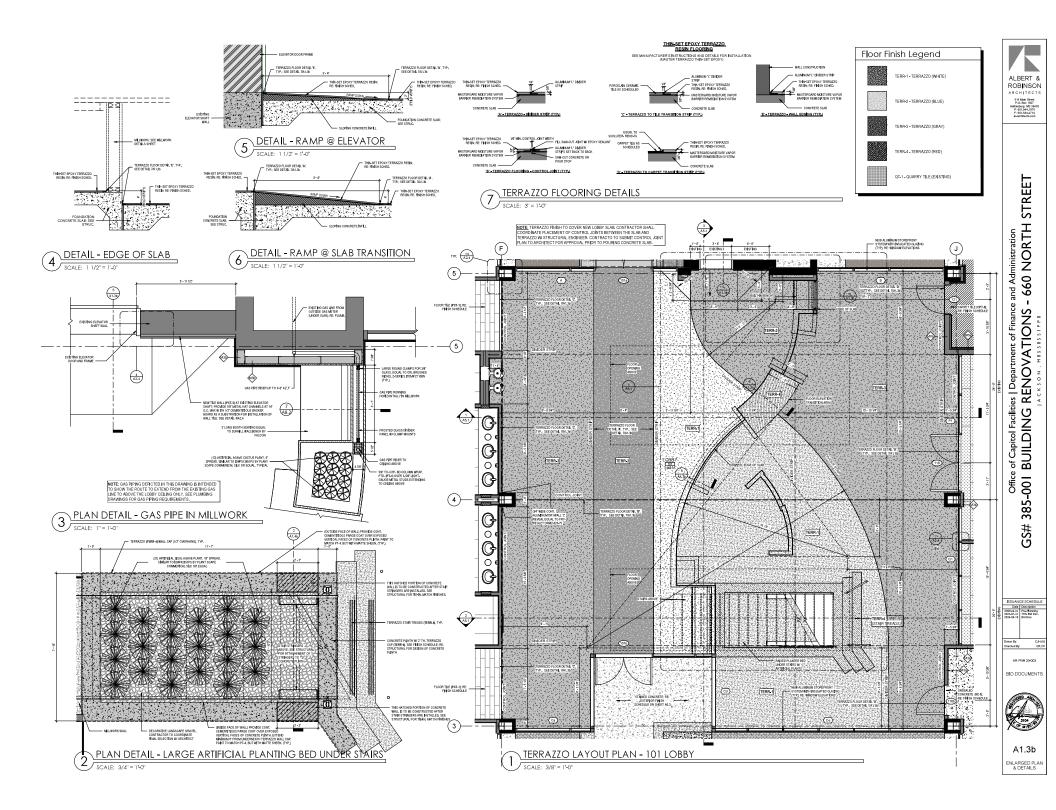

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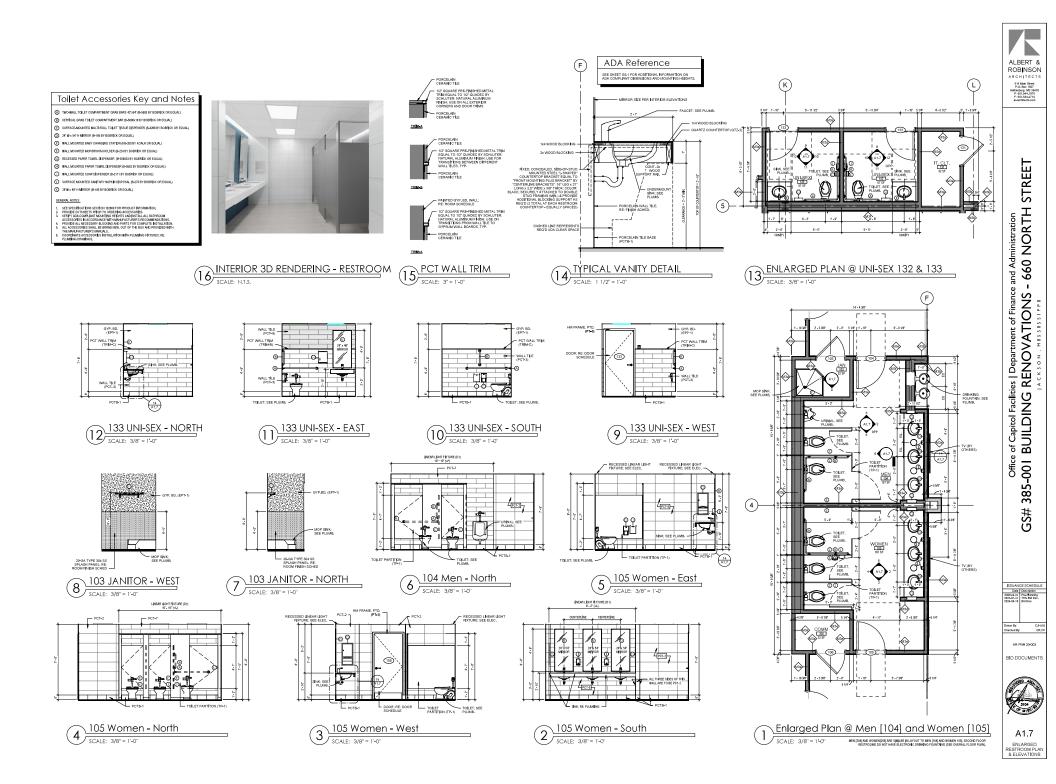
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Office of Capitol Facilities | Department of Finance and Administration GS# 385-001 BUILDING RENOVATIONS - 660 NORTH STREET

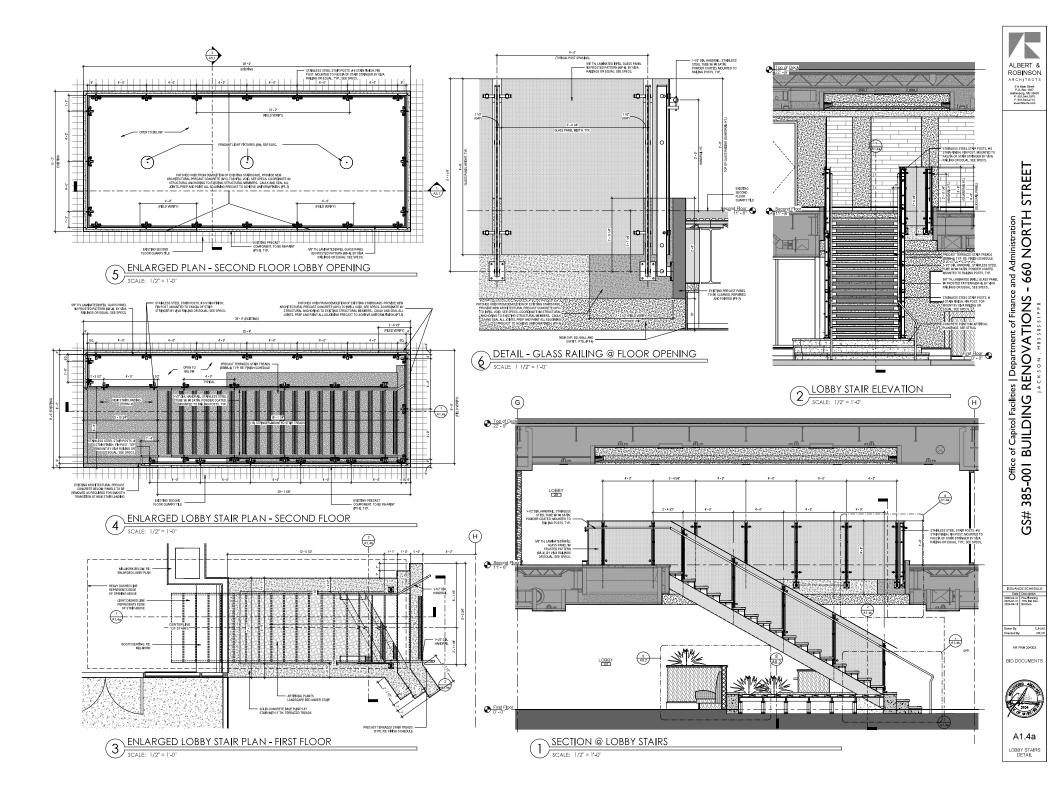

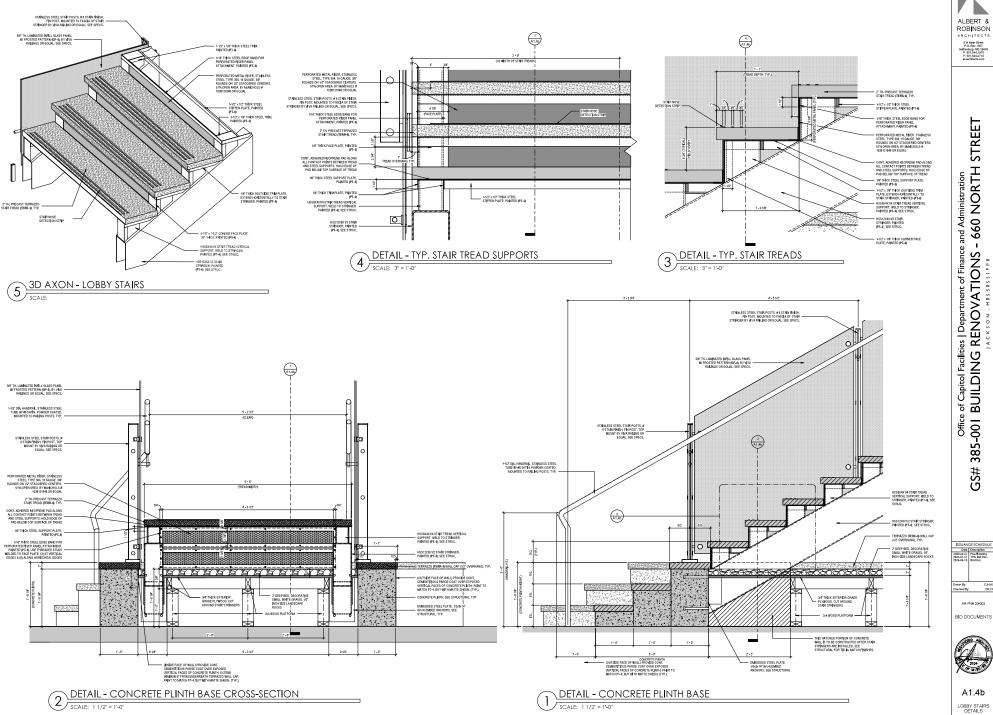

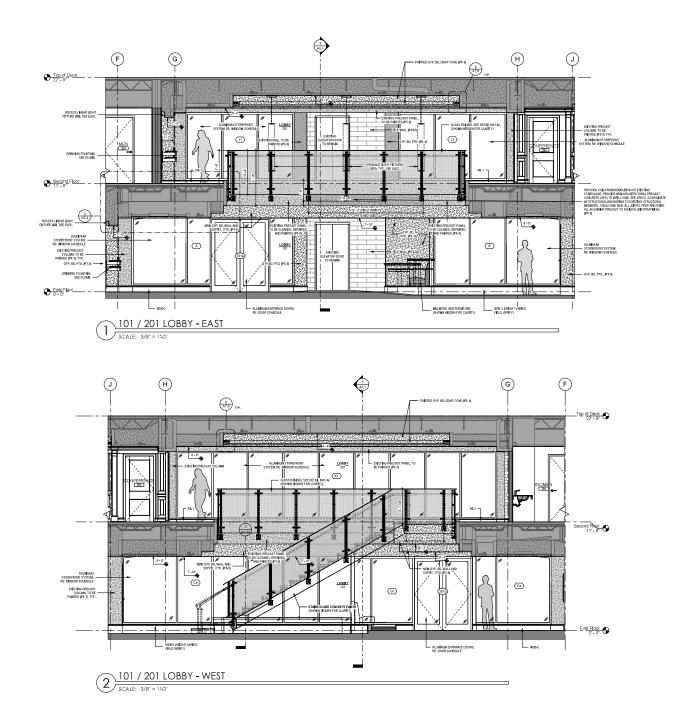A1.6 LOBBY INTERIOR ELEVATIONS









4 INTERIOR 3D RENDERING - JUDICIAL REVIEW 134 VIEW 01 SCALE: N.I.S.

3 INTERIOR 3D RENDERING - JUDICIAL REVIEW 134 VIEW 02 SCALE: N.I.S.




2 INTERIOR 3D RENDERING - TM. OFFICE 122 SCALE: N.J.S.



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ENLARGED PLAN & INTERIOR ELEVATIONS



ISSUANCE SCHEDUL Date Description 2020 ar.ox Pre-Merning 2023.01.31 75% Bid Dec.

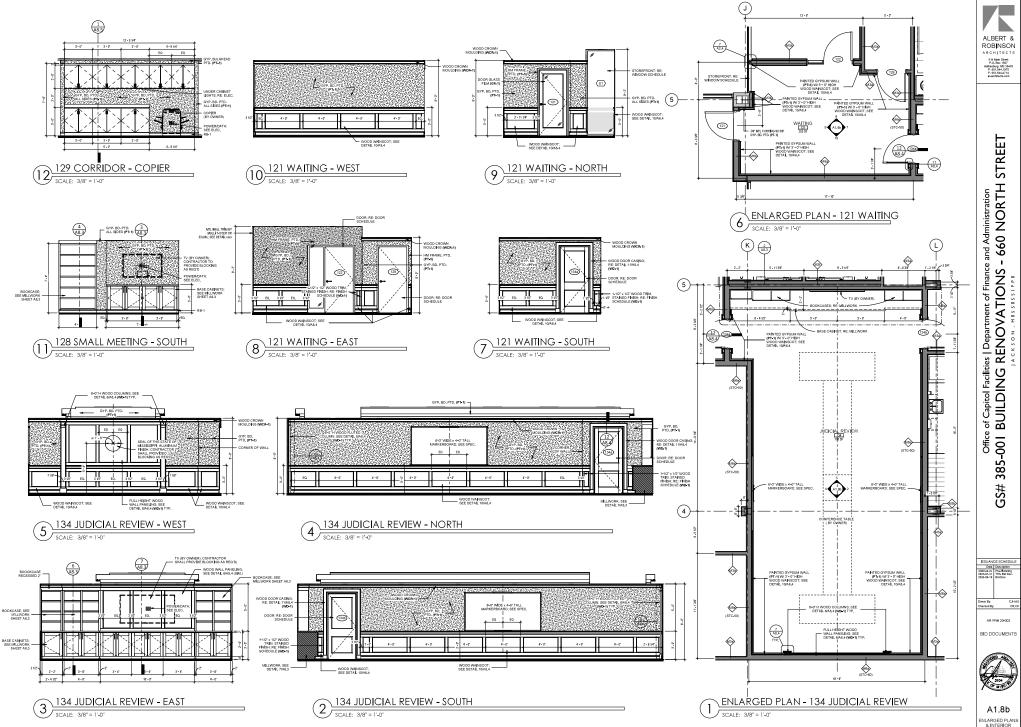A1.9a INTERIOR 3D RENDERING

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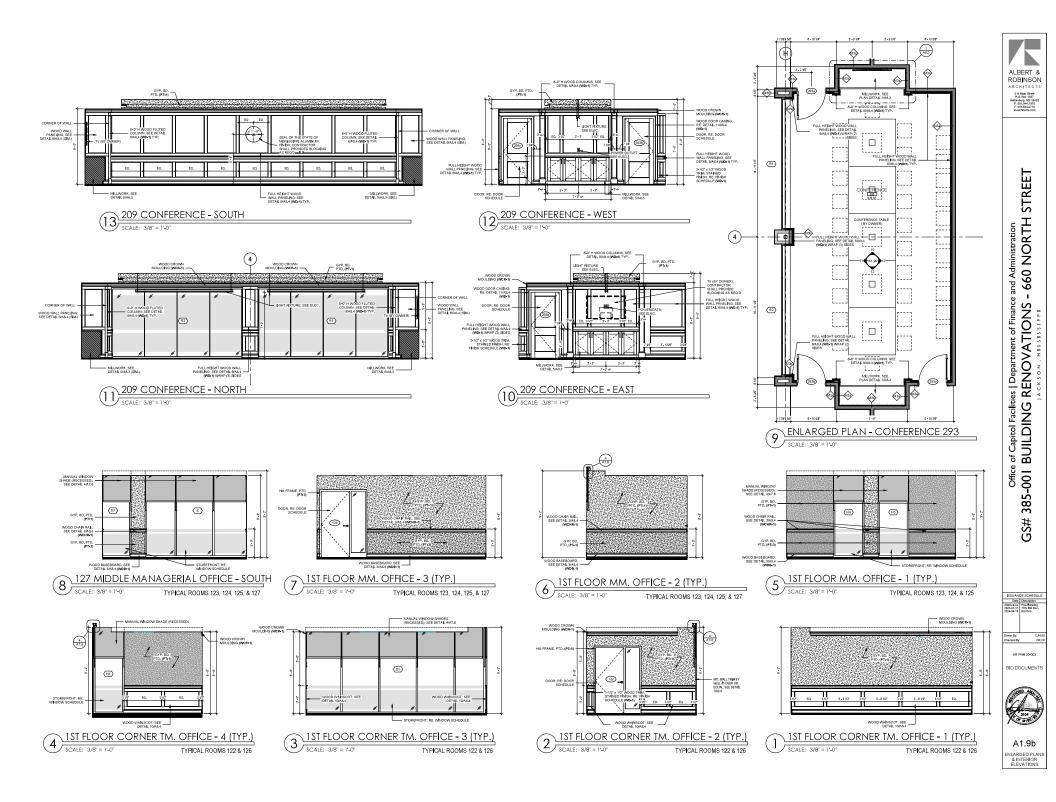
NITERIOR 3D RENDERING - EXECUTIVE OFFICE 260 (4)







2 INTERIOR 3D RENDERING - CONFERENCE 293 VIEW 02 SCALE: N.I.S.





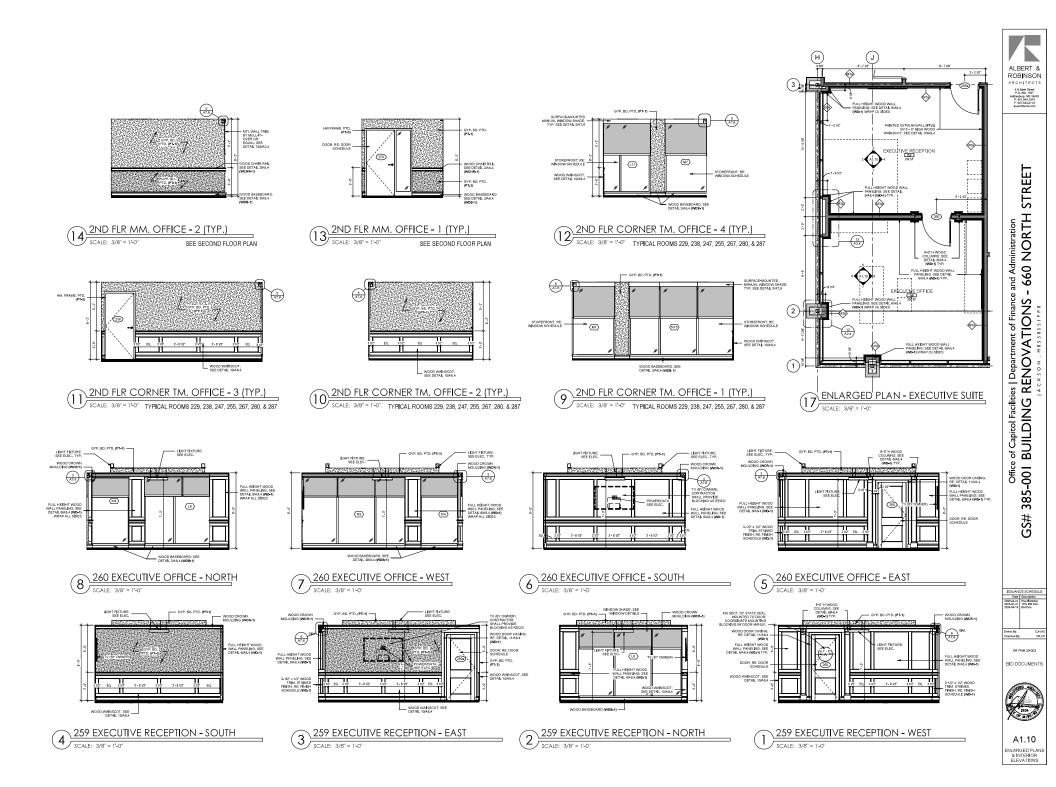

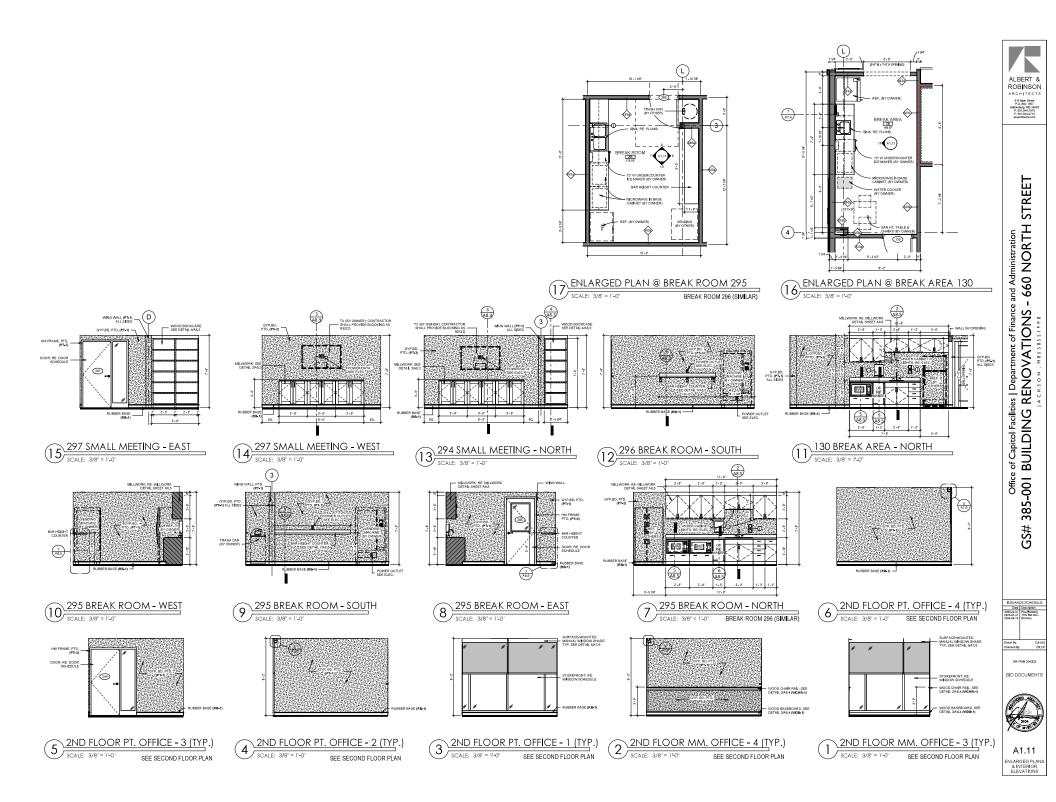



Office of Capitol Facilities | Department of Finance and Administration GS# 385-001 BUILDING RENOVATIONS - 660 NORTH STREET













NINTERIOR 3D RENDERING - CORRIDOR 129 WORK AREA

〔1

11 11 INTERIOR 3D RENDERING - SMALL MEETING 128

3 INTERIOR 3D RENDERING - B. OPEN OFFICE 276 SCALE: NJ.S.







2 INTERIOR 3D RENDERING - BREAK AREA 130 SCALE: N.I.S.

(4)

SCALE: N.T.S.

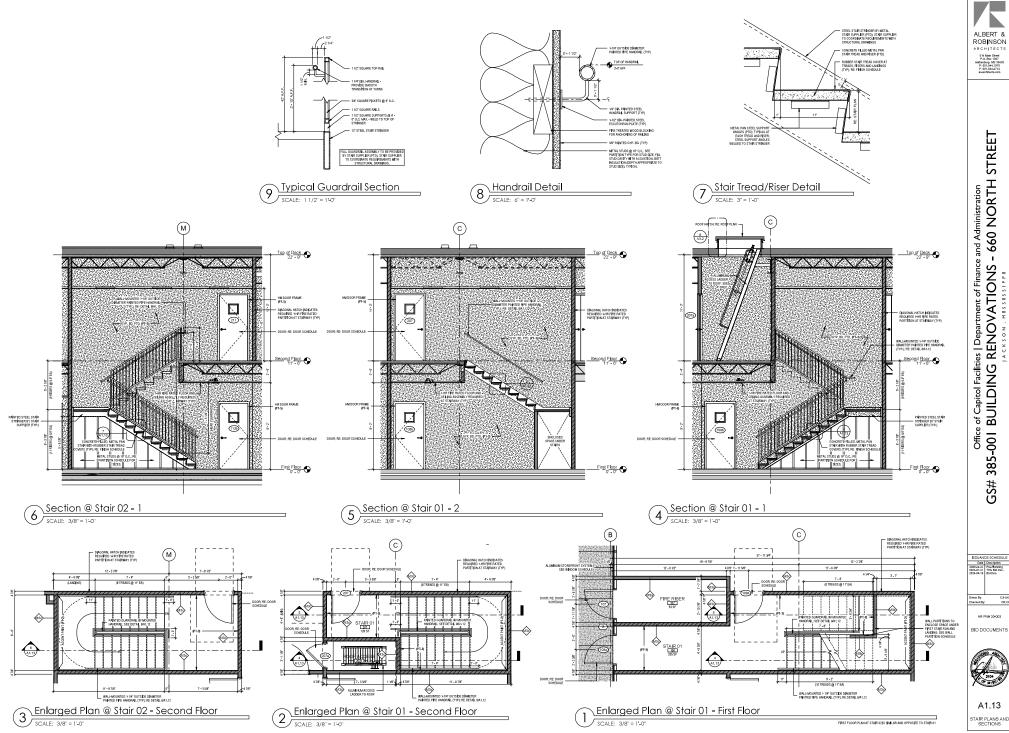

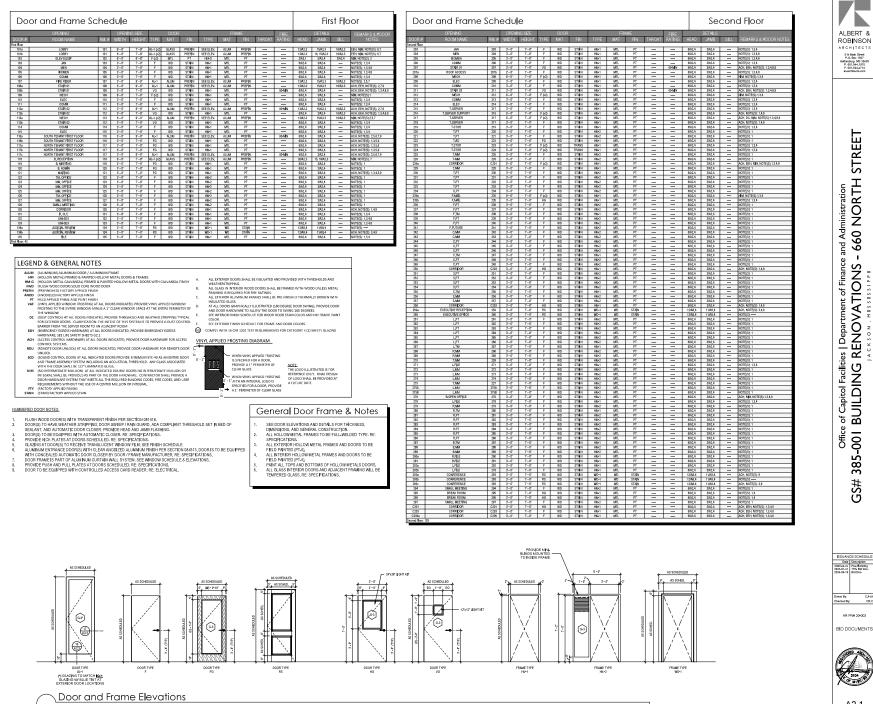

SCALE: 3/8" = 1'-0"

A2.1 DOOR SCHEDULE

3104 0 M195

ALBERT &

ARCHITECTS 514 Main Street

P.0.80x1667 Hetliesburg MS 3940 P: 001:544.1970 F: 601:544.4714 anachtiects.com

STREET

NORTH

660

1


385-001


GS#


CJHAS CR,CR


AR PN# 20-003



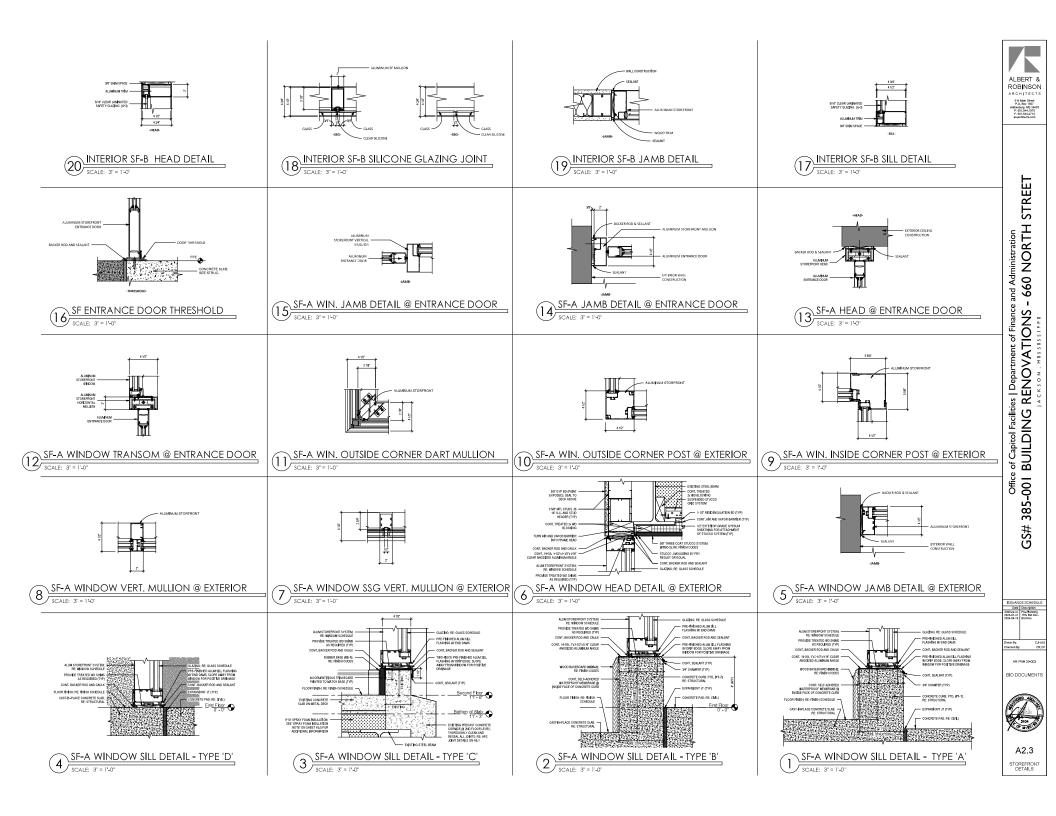

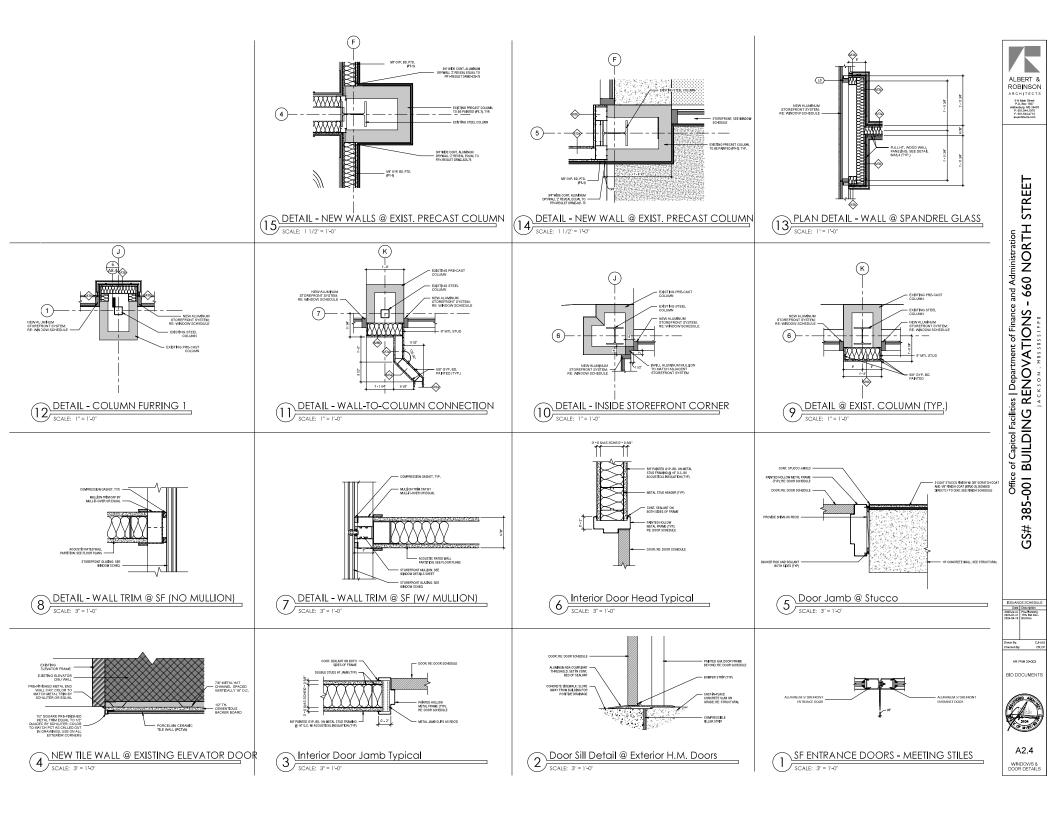

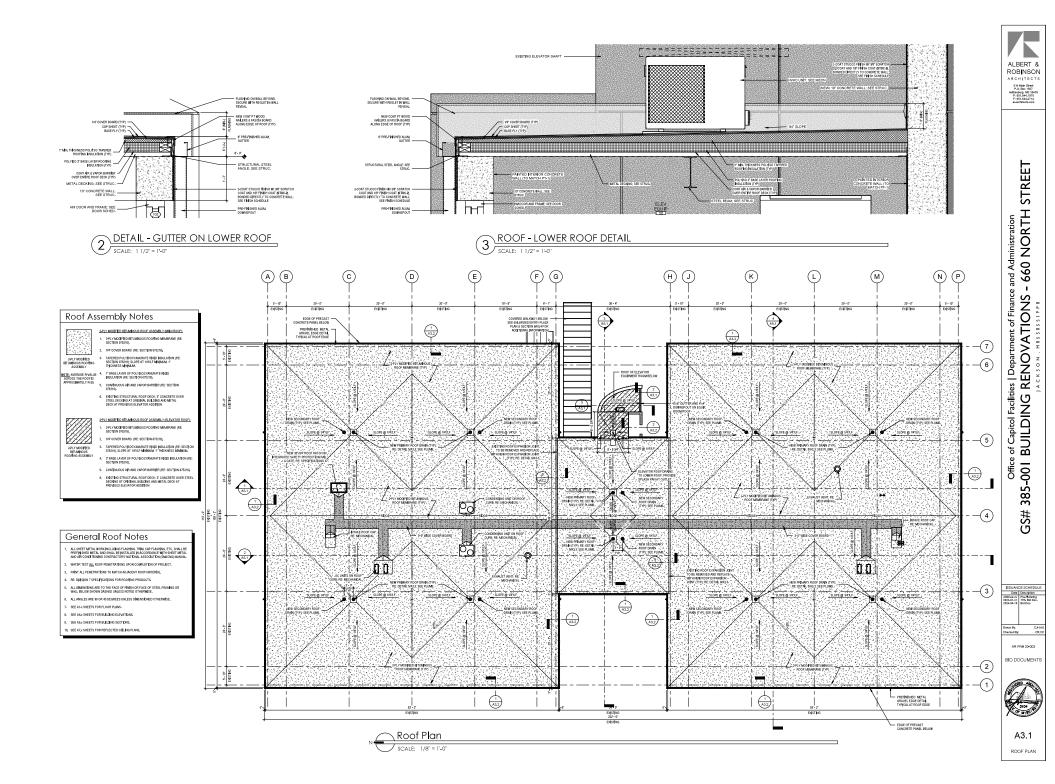

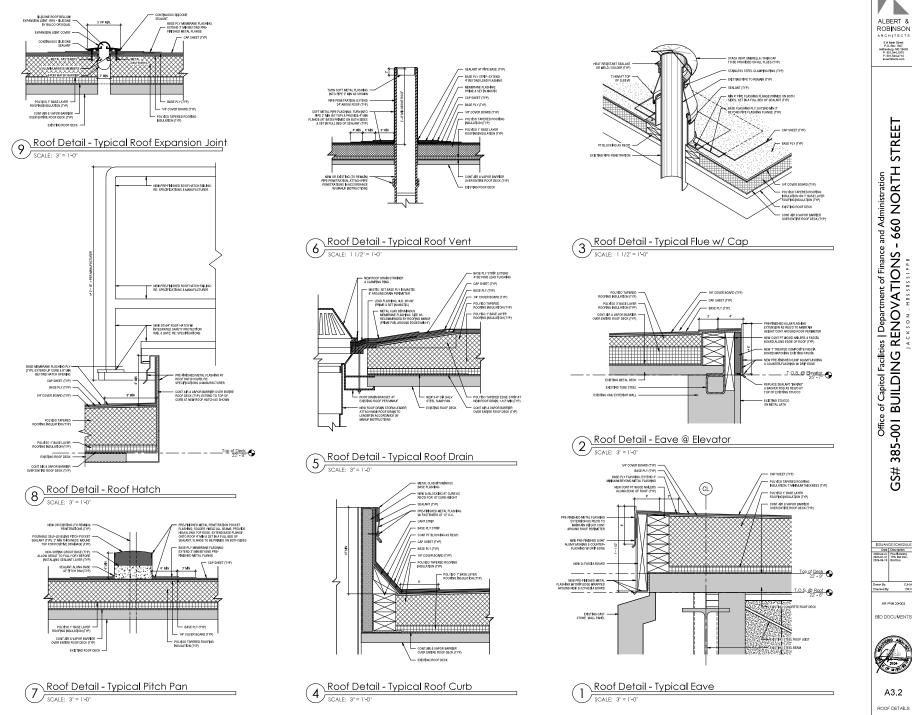



EXTERIOR RENDERING - VIEW FROM NORTH STREET









A4.0 EXTERIOR 3D RENDERINGS

